
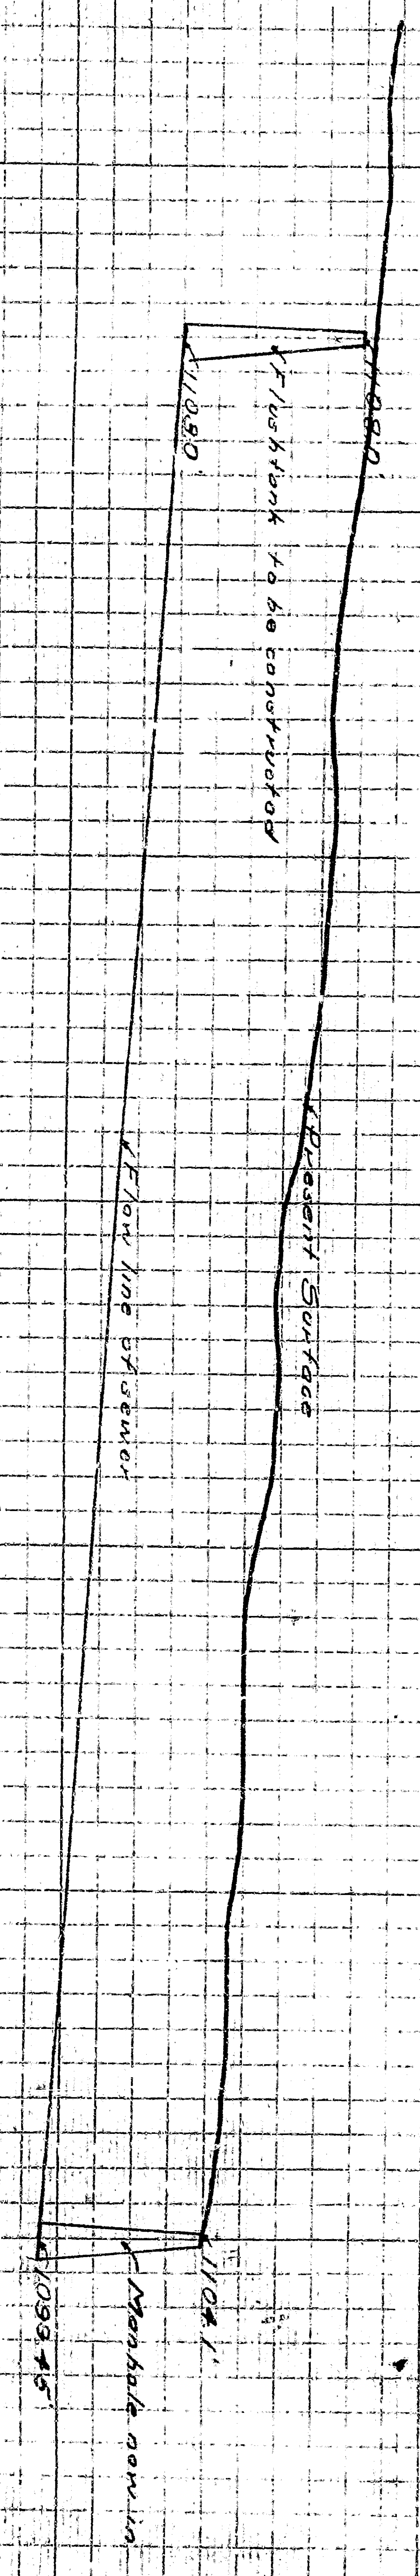


**SHEET NO. 1
 PLAN AND PROFILE NO. 808
 HANSON STREET SEWER
 FROM H STREET TO I STREET
 IN THE
 CITY OF SAN BERNARDINO**

Nov 24 1932
 Scale 1" = 40'
 C. E. Johnson
 City Engineer

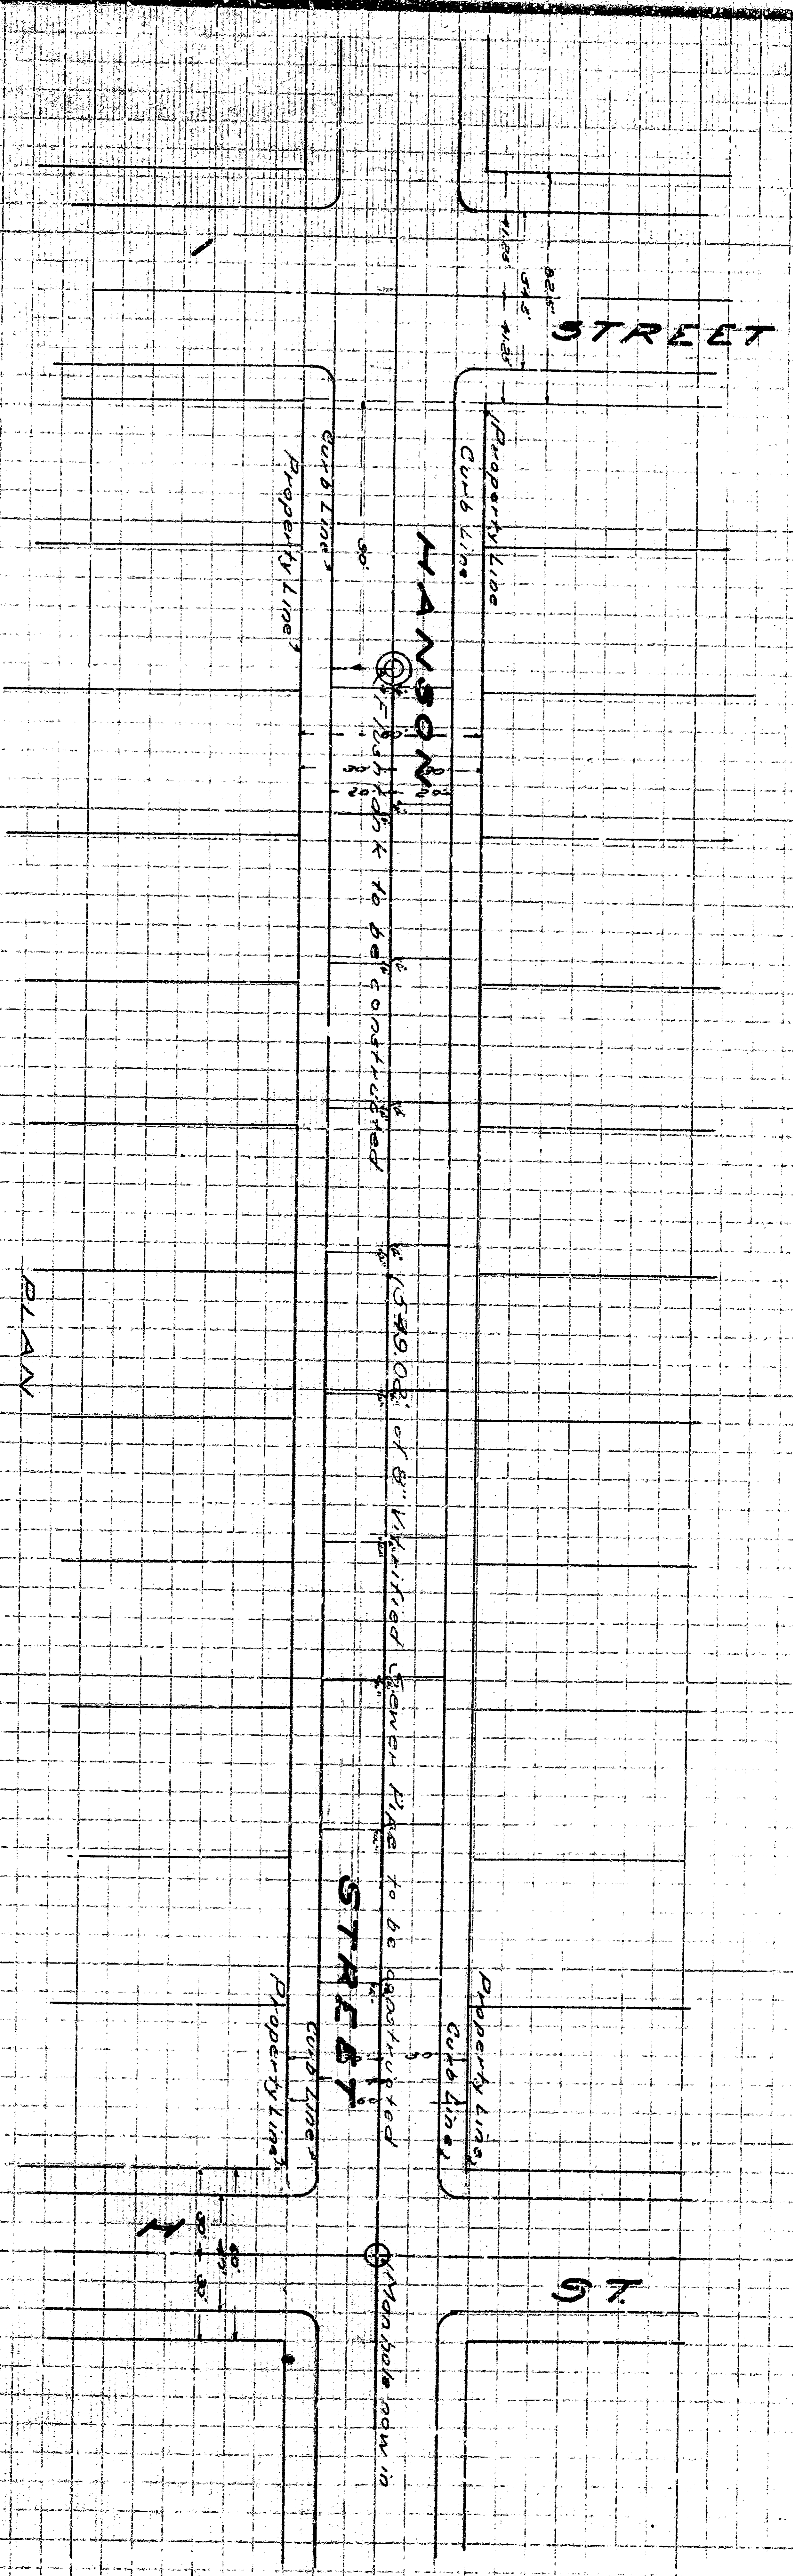

ALL elevations are in feet and decimals thereof. The City Engineer has approved the plan and profile of this sewer line. The City Engineer has also approved the location of the manhole. The City Engineer has also approved the location of the sewer line. The City Engineer has also approved the location of the sewer line.

DETAIL OF SEWER
 1. Line of sewer to be 12" diameter
 2. Material to be vitrified pipe
 3. Manhole to be 48" diameter
 4. Manhole to be 48" diameter
 5. Manhole to be 48" diameter
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 97. Manhole to be 48" diameter
 98. Manhole to be 48" diameter
 99. Manhole to be 48" diameter
 100. Manhole to be 48" diameter

SECTIONAL VIEW SHOWING CROSS SECTION OF SEWER

0+00 0+10 0+20 0+30 0+40 0+50

